LEGAL DESCRIPTION

LOTS 15, 16, 17, 18 AND THE SOUTHERLY 5 FEET OF LOT 19, BLOCK 6, EAST SEATTLE, ACCORDING TO THE PLAT THEREOF RECORDED IN VOLUME 3 OF PLATS, PAGES 22 AND 23, RECORDS OF KING COUNTY, WASHINGTON; EXCEPT THAT PORTION THEREOF LYING WITHIN MERCER ISLAND ROAD (67TH AVENUE SE)

FOUND REBAR &

CAP (TERRANE)

MAILBOX -

SIGN

FIRE HYDRANT

OFFSET 6.00' W

<u>3' USE</u> EASEMENT

SITUATE IN THE CITY OF MERCER ISLAND, COUNTY OF KING, STATE OF WASHINGTON.

BASIS OF BEARING

RECORD OF SURVEY BY TERRANE FOR JAYMARC HOMES, RECORDED ON JULY 26, 2021, IN VOLUME 451 OF SURVEYS, PAGE 259, UNDER RECORDING NO. 20210726900027, RECORDS

VERTICAL DATUM & CONTROL INTERVAL

ELEVATIONS SHOWN ON THIS DRAWING WERE DERIVED FROM INFORMATION PROVIDED BY THE CITY OF MERCER ISLAND.

THE MARK IS A MONUMENT IN CASE AT THE INTERSECTION OF 68TH AVENUE SE W AND SE 32ND STREET.

POINT ID NO. 47746;

ELEVATION: 112.571 FEET - NAVD 88

2.0' CONTOUR INTERVAL - THE EXPECTED VERTICAL ACCURACY IS EQUAL TO 1/2 THE CONTOUR INTERVAL OR PLUS / MINUS 1.0' FOR THIS PROJECT.

SURVEY NOTES

- 1. THIS SURVEY WAS COMPLETED WITHOUT BENEFIT OF A CURRENT TITLE REPORT. EASEMENTS AND OTHER ENCUMBRANCES MAY EXIST ON THIS PROPERTY THAT ARE
- 2. INSTRUMENTATION FOR THIS SURVEY WAS A 3-SECOND SPECTRAPRECISION FOCUS 35 TOTAL STATION. PROCEDURES USED IN THIS SURVEY MEET OR EXCEED STANDARDS SET BY WAC 332-130-090.
- 3. THE INFORMATION ON THIS MAP REPRESENTS THE RESULTS OF A SURVEY MADE IN AUGUST 2021 AND CAN ONLY BE CONSIDERED AS INDICATING THE GENERAL CONDITIONS EXISTING AT THAT TIME.
- 4. UTILITIES SHOWN ON THIS SURVEY ARE BASED UPON ABOVE GROUND OBSERVATIONS AND AS-BUILT PLANS WHERE AVAILABLE. ACTUAL LOCATIONS OF UNDERGROUND UTILITIES MAY VARY AND UTILITIES NOT SHOWN ON THIS SURVEY MAY EXIST ON THIS SITE.
- 5. ALL MONUMENTS WERE LOCATED DURING THIS SURVEY UNLESS OTHERWISE NOTED.

SITE DATA

PROPOSED HARDSCAPE

HIGHEST ELEVATION OF LOT: LOWEST ELEVATION OF LOT: LOT SLOPE: 19.3% TOTAL SITE AREA: 12,500 SF ALLOWED LOT COVERAGE: PROPOSED LOT COVERAGE * 3,899 SF (31.2%)

4,480 SF (35.8%) PROJECT IMPERVIOUS AREA: * LOT COVERAGE INCLUDES THE COMBINATION OF BUILDINGS. INCLUDING EAVES AND ROOF OVERHANGS, AND VEHICULAR DRIVING SURFACES AS DEFINED PER MIMC 19.16.010

581 SF (4.6%)

OWNER / ARCHITECT

WILLIAM E. BUCHAN INC. 2630 116 AVE NE #100 BELLEVUE, WA 98004 (425) 831–5503 CONTACT: DAVID STAVE

ENGINEER THE BLUELINE GROUP

25 CENTRAL WAY, SUITE 400 KIRKLAND, WA 98033 (425) 250-7262 CONTACT: YANNICK METS, PE

GEOTECH ENGINEER

TERRA ASSOCIATES, INC 12220 113TH AVE NE, SUITE 130 KIRKLAND, WA 98034 (425) 821-7777 CONTACT: CAROLYN S. DECKER, PE

SHEET INDEX

CV-01 COVER SHEET 2 TP-01 TESC PLAN 3 TP-02 TESC DETAILS 4 TR-01 TREE RETENTION PLAN

5 SP-01 SITE PLAN 6 SS-01 SIDE SEWER PROFILE

7 TG-01 TEMPORARY GRADING PLAN

8 DT-01 DETAILS 9 DT-02 DETAILS 3036 67TH AVE SE MERCER ISLAND SITE PLAN

VERED CONCRETE PORCH

PROPOSED SINGLE

GFE 100.91


LFE 101.16


ROOF AREA 3641 SF

COVERED CONCRETE PATIO

V− PLANTER

FAMILY RESIDENCE

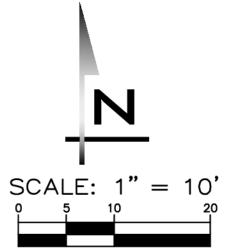

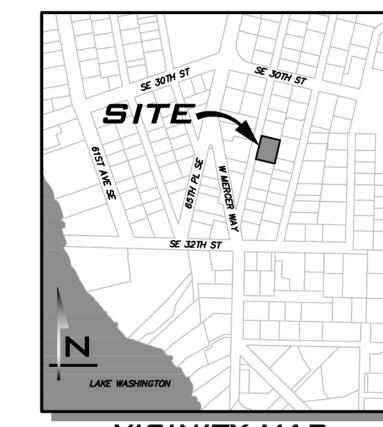

VICINITY MAP NOT TO SCALE

LEGEND PROPOSED FEATURES

-BOUNDARY - RIGHT-OF-WAY - LOT LINE - SIDEWALK - CENTER LINE -- SAWCUT

∠BUILDING FOOTPRINT — — — — — BUILDING OVERHANG BUILDING ROOFLINE ----- — -- Building setback (BSBL)

—— 10' PROPOSED CONTOURS — 2' PROPOSED CONTOURS - STORM DRAIN PIPE

---- ROOF & FOOTING DRAIN

PROPOSED STORM DRAINAGE ■ TYPE I CB — STANDARD GRATE ■ TYPE I CB — LOCKING LID STORM CLEANOUT

TO BE SAVED

TO BE SAVED

TO BE REMOVED

EXISTING DECIDUO
TO BE REMOVED

: ASPHALT

DECIDUOUS TREE

EXISTING CONIFEROUS TREE

EXISTING DECIDUOUS TREE

ASPHALT PAVEMENT

CONCRETE

← ··· **←** ··· SWALE OR DITCH SURFACE FLOW YARD DRAIN EXISTING FEATURES

ADJACENT PLAT/PARCEL LINE P POWER VAULT - ADJACENT RIGHT-OF-WAY **∕**✓ POWER METER - CENTERLINE - EASEMENT \neg MAIL BOX — — — — — SURFACE FEATURES L/L/L/L/L/L/L BUILDING FOOTPRINT — — —190— — — **10' CONTOURS** EXISTING CONIFEROUS TREE ----192---- 2' CONTOURS — — — SD— **Storm drain Pipe** — — — SS— **SEWER MAIN** EXISTING DECIDUOUS TREE — — — W — WATER MAIN > DRIP LINE ————OHP— **AERIAL POWER LINE** CONIFEROUS TREE

————G— GAS MAIN — — — □ — BOARD FENCE RETAINING WALL COOLCOOL ROCKERY ☐ CATCH BASIN, TYPE I CATCH BASIN, TYPE II ⟨ SD PIPE FLOW

SEWER MANHOLE **₩ WATER METER** ⋈ GATE VALVE

-O- POWER POLE CONCRETE ← GUY ANCHOR GRAVEL TESC FEATURES

FILTER FENCE ----- CONSTRUCTION FENCE CLEARED AREA LIMITS OF CLEARING

✓ PIPE FLOW INTERIM CATCH BASIN PROTECTION (INSERT)

EXISTING UTILITY NOTE

EXISTING UTILITIES ARE SHOWN IN THE APPROXIMATE LOCATION. THERE IS NO GUARANTEE THAT ALL UTILITY LINES ARE SHOWN, OR THAT THE LOCATION, SIZE AND MATERIAL IS ACCURATE. THE CONTRACTOR SHALL UNCOVER ALL INDICATED PIPING WHERE CROSSING, INTERFERENCES, OR CONNECTIONS OCCUR PRIOR TO TRENCHING OR EXCAVATION FOR ANY PIPE OR STRUCTURES, TO DETERMINE ACTUAL LOCATIONS, SIZE AND MATERIAL. THE CONTRACTOR SHALL MAKE THE APPROPRIATE PROVISION FOR PROTECTION OF SAID FACILITIES. THE CONTRACTOR SHALL NOTIFY ONE CALL AT 8-1-1 (WASHINGTON811.COM) AND ARRANGE FOR FIELD LOCATION OF EXISTING FACILITIES BEFORE CONSTRUCTION.



KIRKLAND, WA 98033 P: 425.216.4051 F: 425.216.4052 WWW.ATWELL-GROUP.COM

SCALE: AS NOTED PROJECT MANAGER: YANNICK METS, PE PROJECT ENGINEER: ALI RAMEZANI, PE

DESIGNER: CHRISTOPHER WISCOMB ISSUE DATE: 11/20/2023

July 1

11/20/23 JOB NUMBER: 22-042

SHEET NAME: CV-01

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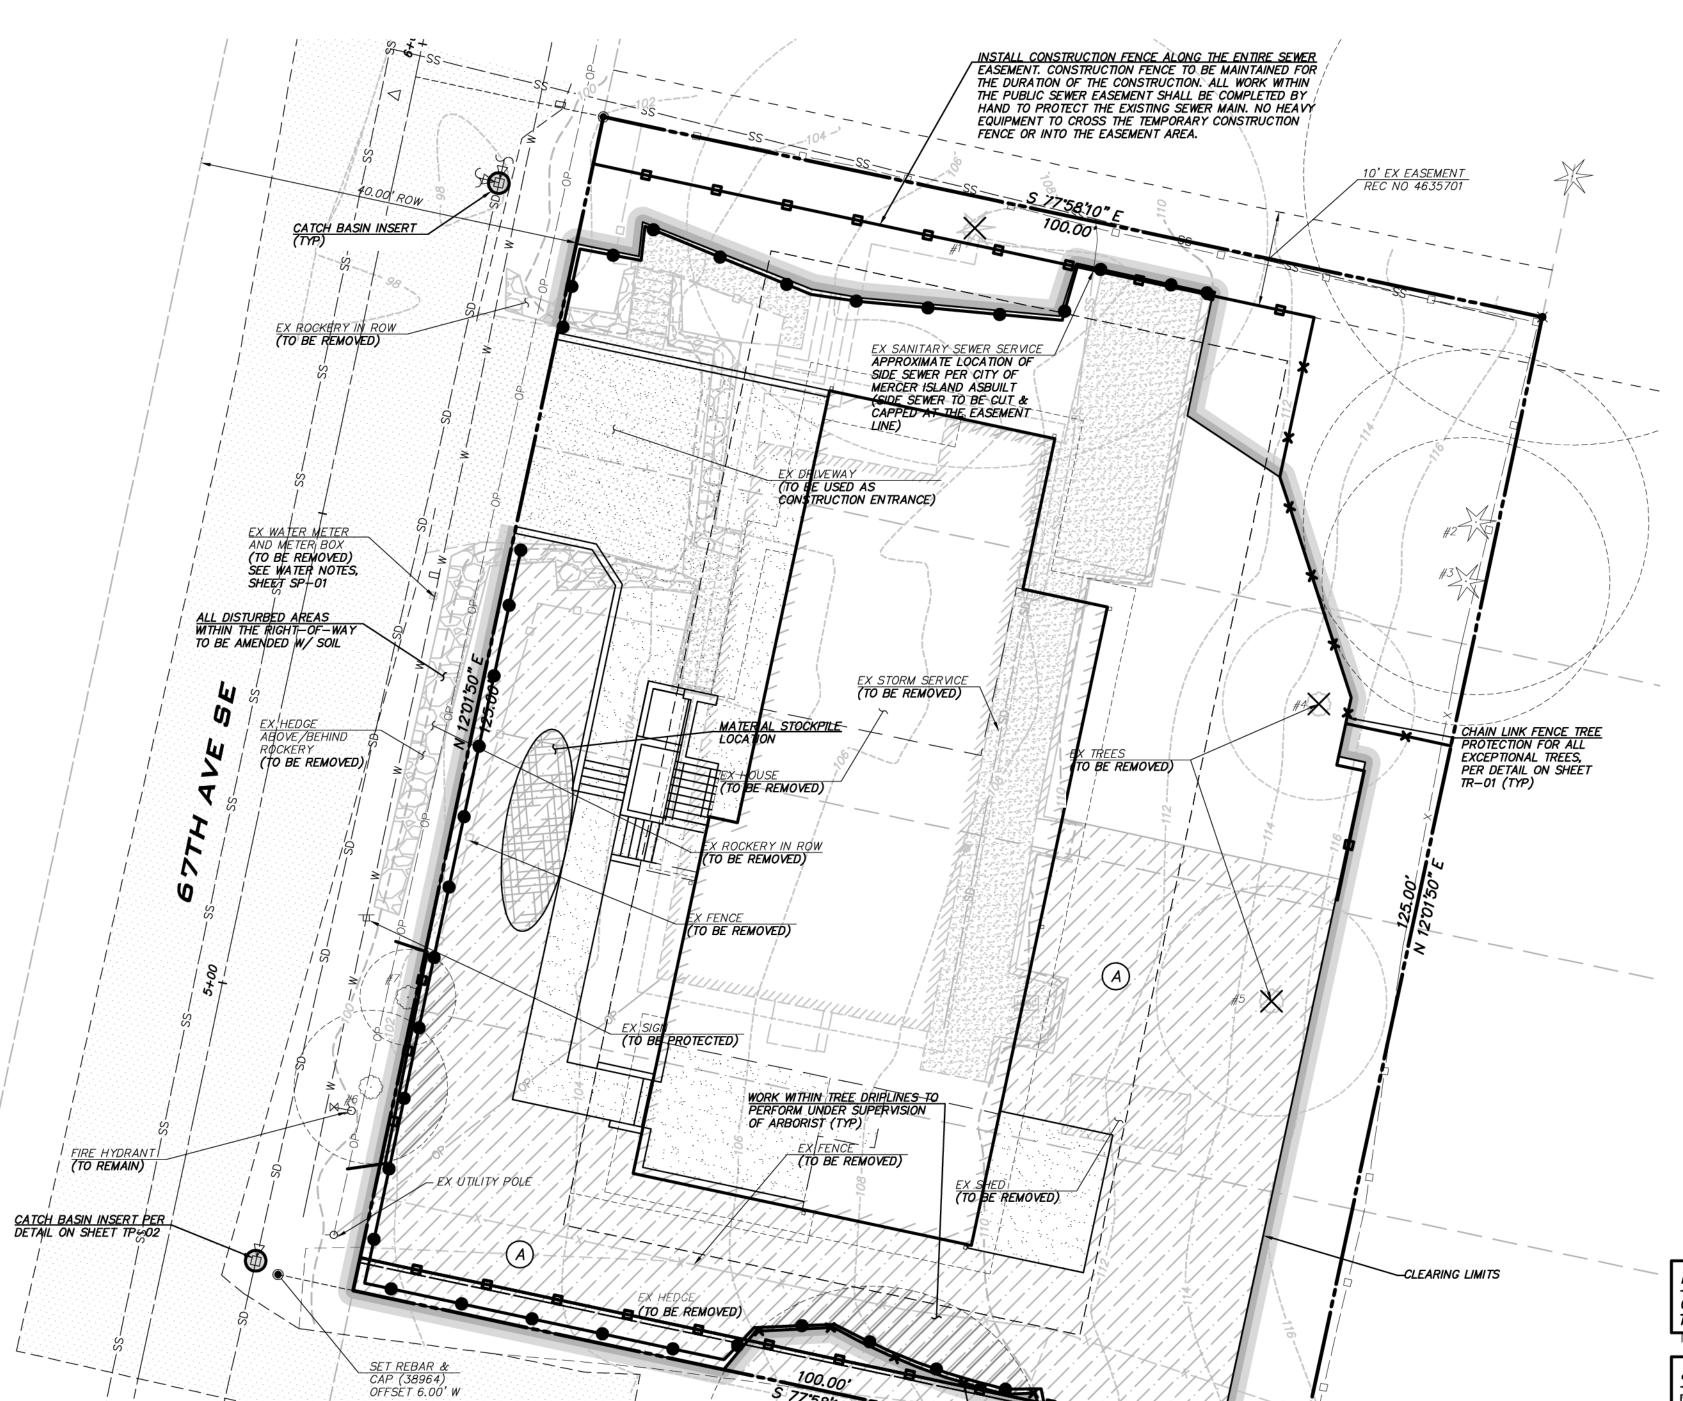


SET REBAR & CAP (38964)

SEE ARCHITECTURAL SITE PLAN FOR TREE RETENTION, BUILDING HEIGHTS AND FAR CALCULATIONS.


DF 36


PROPOSED RETAINING
WALL PER ARCH



CHAIN LINK FENCE TREE PROTECTION FOR ALL

EXCEPTIONAL TREES, PER DETAIL ON SHEET TR-01 (TYP)

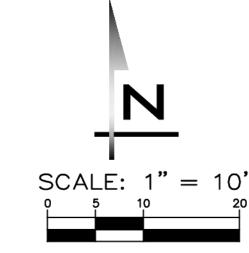

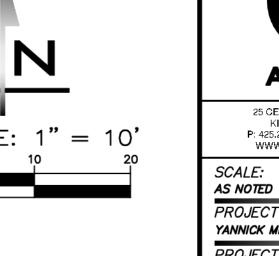

NOTE

CATCH BASIN INLET PROTECTION TO BE INSTALLED UP TO 250' DOWNSTREAM OF THE PROJECT SITE.

SOIL AMENDMENT LEGEND

SILT FENCE PER DETAIL
ON SHEET TP-02

A NEW TURF AREA REQUIRING AMENDMENT (3,602 SF)

POST-CONSTRUCTION SOIL MANAGEMENT NOTES

AMEND SOILS WITH COMPOST PER PRE-APPROVED AMENDMENT METHOD

SCARIFY EXISTING SOILS TO DEPTH OF 8 INCHES

REFER TO CITY OF MERCER ISLAND SECTION D: POST-CONSTRUCTION SOIL MANAGEMENT FORM UNDER SEPARATE COVER FOR CALCULATED AMENDMENT QUANTITIES.

NOTE

EXISTING WATER METER TO BE ABANDONED.

EXISTING UTILITY NOTE

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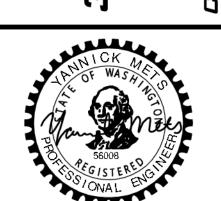
SCALE:

PROJECT MANAGER: YANNICK METS, PE

PROJECT ENGINEER: ALI RAMEZANI, PE

DESIGNER: CHRISTOPHER WISCOMB ISSUE DATE:

11/20/2023



11/20/23 JOB NUMBER:

22-042 SHEET NAME: TP-01

внт **2** оғ **9**

- 1. THE APPROVED CONSTRUCTION SEQUENCE SHALL BE AS FOLLOWS:
 - A. CONDUCT PRE-CONSTRUCTION MEETING. B. FLAG OR FENCE CLEARING LIMITS.
 - C. POST SIGN WITH NAME AND PHONE NUMBER OF TESC SUPERVISOR.
 - D. INSTALL CATCH BASIN PROTECTION IF REQUIRED.
 - E. GRADE AND INSTALL CONSTRUCTION ENTRANCE(S).


 - F. INSTALL PERIMETER PROTECTION (SILT FENCE, BRUSH BARRIER, ETC.).
 - G. CONSTRUCT SEDIMENT PONDS AND TRAPS. H. GRADE AND STABILIZE CONSTRUCTION ROADS.
 - I. CONSTRUCT SURFACE WATER CONTROLS (INTERCEPTOR DIKES, PIPE SLOPE DRAINS, ETC.) SIMULTANEOUSLY WITH CLEARING AND GRADING FOR PROJECT DEVELOPMENT. J. MAINTAIN EROSION CONTROL MEASURE IN ACCORDANCE WITH CITY OF MERCER ISLAND
- STANDARDS AND MANUFACTURER'S RECOMMENDATIONS. K. RELOCATE EROSION CONTROL MEASURES OR INSTALL NEW MEASURES SO THAT AS SITE
- CONDITIONS CHANGE, THE EROSION AND SEDIMENT CONTROL IS ALWAYS IN ACCORDANCE WITH THE CITY TESC MINIMUM REQUIREMENTS. L. COVER ALL AREAS WITHIN THE SPECIFIED TIME FRAME WITH STRAW, WOOD FIBER MULCH,
- COMPOST, PLASTIC SHEETING, CRUSHED ROCK OR EQUIVALENT. M. STABILIZE ALL AREAS THAT REACH FINAL GRADE WITHIN 7 DAYS.
- N. SEED OR SOD ANY AREAS TO REMAIN UNWORKED FOR MORE THAN 30 DAYS. O. UPON COMPLETION OF THE PROJECT, ALL DISTURBED AREAS MUST BE STABILIZED AND BEST MANAGEMENT PRACTICES REMOVED IF APPROPRIATE.
- APPROVAL OF THIS EROSION/SEDIMENTATION CONTROL (ESC) PLAN DOES NOT CONSTITUTE AN APPROVAL OF PERMANENT ROAD OR DRAINAGE DESIGN (E.G., SIZE AND LOCATION OF ROADS, PIPES, RESTRICTORS, CHANNELS, RETENTION FACILITIES, UTILITIES, ETC.).
- 3. THE IMPLEMENTATION OF THIS ESC PLAN AND THE CONSTRUCTION, MAINTENANCE, REPLACEMENT, AND UPGRADING OF THESE ESC FACILITIES IS THE RESPONSIBILITY OF THE PERMITTEE/CONTRACTOR UNTIL ALL CONSTRUCTION IS APPROVED.
- 4. THE BOUNDARIES OF THE CLEARING LIMITS SHOWN ON THIS PLAN SHALL BE SET BY SURVEY AND CLEARLY FLAGGED IN THE FIELD BY A CLEARING CONTROL FENCE PRIOR TO CONSTRUCTION. DURING THE CONSTRUCTION PERIOD, NO DISTURBANCE OR REMOVAL OF ANY GROUND COVER BEYOND THE FLAGGED CLEARING LIMITS SHALL BE PERMITTED. THE FLAGGING SHALL BE MAINTAINED BY THE PERMITTEE/CONTRACTOR FOR THE DURATION OF
- CONSTRUCTION. THE TESC FACILITIES SHOWN ON THIS PLAN MUST BE CONSTRUCTED PRIOR TO OR IN CONJUNCTION WITH ALL CLEARING AND GRADING ACTIVITIES IN SUCH A MANNER AS TO ENSURE THAT SEDIMENT-LADEN WATER DOES NOT ENTER THE DRAINAGE SYSTEM OR VIOLATE APPLICABLE WATER STANDARDS. WHEREVER POSSIBLE, MAINTAIN NATURAL VEGETATION FOR SILT CONTROL.
- 6. THE ESC FACILITIES SHOWN ON THIS PLAN ARE THE MINIMUM REQUIREMENTS FOR ANTICIPATED SITE CONDITIONS. DURING THE CONSTRUCTION PERIOD, THESE ESC FACILITIES SHALL BE UPGRADED (E.G., ADDITIONAL SUMPS, RELOCATION OF DITCHES AND SILT FENCES, ETC.) AS NEEDED FOR UNEXPECTED STORM EVENTS. ADDITIONALLY, MORE TESC FACILITIES MAY BE REQUIRED TO ENSURE COMPLETE SILTATION CONTROL. THEREFORE, DURING THE COURSE OF CONSTRUCTION IT SHALL BE THE OBLIGATION AND RESPONSIBILITY OF THE CONTRACTOR TO ADDRESS ANY NEW CONDITIONS THAT MAY BE CREATED BY HIS ACTIVITIES AND TO PROVIDE ADDITIONAL FACILITIES OVER AND ABOVE THE MINIMUM REQUIREMENTS AS MAY BE NEEDED.
- 7. THE ESC FACILITIES SHALL BE INSPECTED BY THE PERMITTEE/CONTRACTOR DAILY DURING NON-RAINFALL PERIODS, EVERY HOUR (DAYLIGHT) DURING A RAINFALL EVENT, AND AT THE END OF EVERY RAINFALL, AND MAINTAINED AS NÉCESSARY TO ENSURE THEIR CONTINUED FUNCTIONING. IN ADDITION, TEMPORARY SILTATION PONDS AND ALL TEMPORARY SILTATION CONTROLS SHALL BE MAINTAINED IN A SATISFACTORY CONDITION UNTIL SUCH TIME THAT CLEARING AND OR CONSTRUCTION IS COMPLETED, PERMANENT DRAINAGE FACILITIES ARE OPERATIONAL, AND THE POTENTIAL FOR EROSION HAS PASSED. WRITTEN RECORDS SHALL BE KEPT DOCUMENTING THE REVIEWS OF THE ESC FACILITIES.
- 8. THE ESC FACILITIES ON INACTIVE SITES SHALL BE INSPECTED AND MAINTAINED A MINIMUM OF ONCE A MONTH OR WITHIN 48 HOURS FOLLOWING A STORM EVENT.
- 9. ALL DENUDED SOILS MUST BE STABILIZED WITH AN APPROVED TESC METHOD (E.G. SEEDING, MULCHING, PLASTIC COVERING, CRUSHED ROCK) WITHIN THE FOLLOWING TIMELINES: APRIL 1 TO OCTOBER 31 — SOILS MUST BE STABILIZED WITHIN 7 DAYS OF GRADING.
- NOVEMBER 1 TO MARCH 31 SOILS MUST BE STABILIZED WITHIN 2 DAYS OF GRADING. 10. At no time shall more than 1' of sediment be allowed to accumulate within a CATCH BASIN. ALL CATCH BASINS AND CONVEYANCE LINES SHALL BE CLEANED PRIOR TO PAVING. THE CLEANING OPERATION SHALL NOT FLUSH SEDIMENT-LADEN WATER INTO THE DOWNSTREAM SYSTEM.
- 11. STABILIZED CONSTRUCTION ENTRANCES SHALL BE INSTALLED AT THE BEGINNING OF CONSTRUCTION AND MAINTAINED FOR THE DURATION OF THE PROJECT. ADDITIONAL MEASURES, SUCH AS WASH PADS, MAY BE REQUIRED TO ENSURE THAT ALL PAVED AREAS ARE KEPT CLEAN FOR THE DURATION OF THE PROJECT.
- 12. ANY PERMANENT RETENTION/DETENTION FACILITY USED AS A TEMPORARY SETTLING BASIN SHALL BE MODIFIED WITH THE NECESSARY EROSION CONTROL MEASURES AND SHALL PROVIDE ADEQUATE STORAGE CAPACITY. IF THE PERMANENT FACILITY IS TO FUNCTION ULTIMATELY AS AN INFILTRATION OR DISPERSION SYSTEM, THE FACILITY SHALL NOT BE USED AS A TEMPORARY SETTLING BASIN. NO UNDERGROUND DETENTION TANK, DETENTION VAULT, OR SYSTEM WHICH BACKS UNDER OR INTO A POND SHALL BE USED AS A TEMPORARY SETTLING BASIN.
- WHERE SEEDING FOR TEMPORARY EROSION CONTROL IS REQUIRED, FAST GERMINATING GRASSES SHALL BE APPLIED AT AN APPROPRIATE RATE (EXAMPLE: ANNUAL OR PERENNIAL RYE APPLIED AT APPROXIMATELY 80 POUNDS PER ACRE).
- 14. WHERE STRAW MULCH IS REQUIRED FOR TEMPORARY ERÓSION CONTROL, IT SHALL BE APPLIED AT A MINIMUM THICKNESS OF 2".
- 15. ALL EROSION/SEDIMENTATION CONTROL PONDS WITH A DEAD STORAGE DEPTH EXCEEDING 6" MUST HAVE A PERIMETER FENCE WITH A MINIMUM HEIGHT OF 3'.
- 16. ALL WORK AND MATERIALS SHALL BE IN ACCORDANCE WITH CITY OF MERCER ISLAND STANDARDS AND SPECIFICATIONS.
- 17. THE ESC FACILITIES SHALL BE CONSTRUCTED IN ACCORDANCE WITH THE DETAILS ON THE APPROVED PLANS. LOCATIONS MAY BE MOVED TO SUIT FIELD CONDITIONS, SUBJECT TO
- APPROVAL BY THE ENGINEER AND THE CITY OF MERCER ISLAND INSPECTOR. 18. A COPY OF THE APPROVED EROSION CONTROL PLANS MUST BE ON THE JOB SITE WHENEVER
- CONSTRUCTION IS IN PROGRESS. 19. ALL LOTS ADJOINING OR HAVING ANY NATIVE GROWTH PROTECTION EASEMENTS (NGPE) SHALL HAVE A 4' HIGH TEMPORARY CONSTRUCTION FENCE (CYCLONE OR PLASTIC MESH)
- SEPARATING THE LOT (OR BUILDABLE PORTIONS OF THE LOT) FROM THE AREA RESTRICTED BY THE NGPE AND SHALL BE INSTALLED PRIOR TO ANY GRADING OR CLEARING AND REMAIN IN PLACE UNTIL A DWELLING IS CONSTRUCTED AND OWNERSHIP TRANSFERRED TO THE FIRST OWNER/OCCUPANT. 20. CLEARÍNG LIMITS SHALL BE DELINEATED WITH A CLEARING CONTROL FENCE. THE CLEARING CONTROL FENCE SHALL CONSIST OF A 6-FT. HIGH CHAIN LINK FENCE ADJACENT THE DRIP


LINE OF TREES TO BE SAVED, WETLAND OR STREAM BUFFERS, AND SENSITIVE SLOPES.


- CLEARING CONTROL FENCES ALONG WETLAND OR STREAM BUFFERS OR UPSLOPE OF SENSITIVE SLOPES SHALL BE ACCOMPANIED BY AN EROSION CONTROL FENCE. IF APPROVED BY THE CITY. A FOUR-FOOT HIGH ORANGE MESH CLEARING CONTROL FENCE MAY BE USED TO DELINEATE CLEARING LIMITS IN ALL OTHER AREAS. 21. OFF-SITE STREETS MUST BE KEPT CLEAN AT ALL TIMES. IF DIRT IS DEPOSITED ON THE PUBLIC STREET SYSTEM, THE STREET SHALL BE IMMEDIATELY CLEANED WITH POWER
- SWEEPER OR OTHER EQUIPMENT. ALL VEHICLES SHALL LEAVE THE SITE BY WAY OF THE CONSTRUCTION ENTRANCE AND SHALL BE CLEANED OF ALL DIRT THAT WOULD BE DEPOSITED ON THE PUBLIC STREETS. 22. ANY CATCH BASINS COLLECTING RUNOFF FROM THE SITE, WHETHER THEY ARE ON OR OFF THE SITE, SHALL HAVE THEIR GRATES COVERED WITH FILTER FABRIC DURING CONSTRUCTION. CATCH BASINS DIRECTLY DOWNSTREAM OF THE CONSTRUCTION ENTRANCE OR ANY OTHER


CATCH BASIN AS DETERMINED BY THE CITY INSPECTOR SHALL BE PROTECTED WITH A "FILTER


- FABRIC SOCK" OR EQUIVALENT. 23. THE WASHED GRAVEL BACKFILL ADJACENT TO THE FILTER FABRIC FENCE SHALL BE REPLACED AND THE FILTER FABRIC CLEANED IF IT IS NONFUNCTIONAL BY EXCESSIVE SILT ACCUMULATION AS DETERMINED BY THE CITY OF MERCER ISLAND. ALSO, ALL INTERCEPTOR
- SWALES SHALL BE CLEANED IF SILT ACCUMULATION EXCEEDS ONE—QUARTER DEPTH. 24. ROCK FOR EROSION PROTECTION OF ROADWAY DITCHES, WHERE REQUIRED, MUST BE OF SOUND QUARRY ROCK, PLACED TO A DEPTH OF 1' AND MUST MEET THE FOLLOWING SPECIFICATIONS: 4"-8" ROCK/40 %-70 % PASSING; 2"-4" ROCK/30 %-40 % PASSING; AND 1"-2" ROCK/10 %-20 % PASSING.
- 25. IF ANY PART(S) OF THE CLEARING LIMIT BOUNDARY OR TEMPORARY EROSION/SEDIMENTATION CONTROL PLAN IS/ARE DAMAGED, IT SHALL BE REPAIRED IMMEDIATELY.
- 26. ALL PROPERTIES ADJACENT TO THE PROJECT SITE SHALL BE PROTECTED FROM SEDIMENT DEPOSITION AND RUNOFF.
- 27. DO NOT FLUSH CONCRETE BY-PRODUCTS OR TRUCKS NEAR OR INTO THE STORM DRAINAGE SYSTEM. IF EXPOSED AGGREGATE IS FLUSHED INTO THE STORM SYSTEM, IT COULD MEAN RE-CLEANING THE ENTIRE DOWNSTREAM STORM SYSTEM, OR POSSIBLY RE-LAYING THE STORM LINE.
- 28. PRIOR TO THE OCTOBER 1 OF EACH YEAR (THE BEGINNING OF THE WET SEASON), ALL DISTURBED AREAS SHALL BE REVIEWED TO IDENTIFY WHICH ONES CAN BE SEEDED IN PREPARATION FOR THE WINTER RAINS. THE IDENTIFIED DISTURBED AREA SHALL BE SEEDED WITHIN ONE WEEK AFTER OCTOBER 1. A SITE PLAN DEPICTING THE AREAS TO BE SEEDED AND THE AREAS TO REMAIN UNCOVERED SHALL BE SUBMITTED TO THE PUBLIC WORKS CONSTRUCTION INSPECTOR. THE INSPECTOR CAN REQUIRE SEEDING OF ADDITIONAL AREAS IN ORDER TO PROTECT SURFACE WATERS, ADJACENT PROPERTIES, OR DRAINAGE FACILITIES.

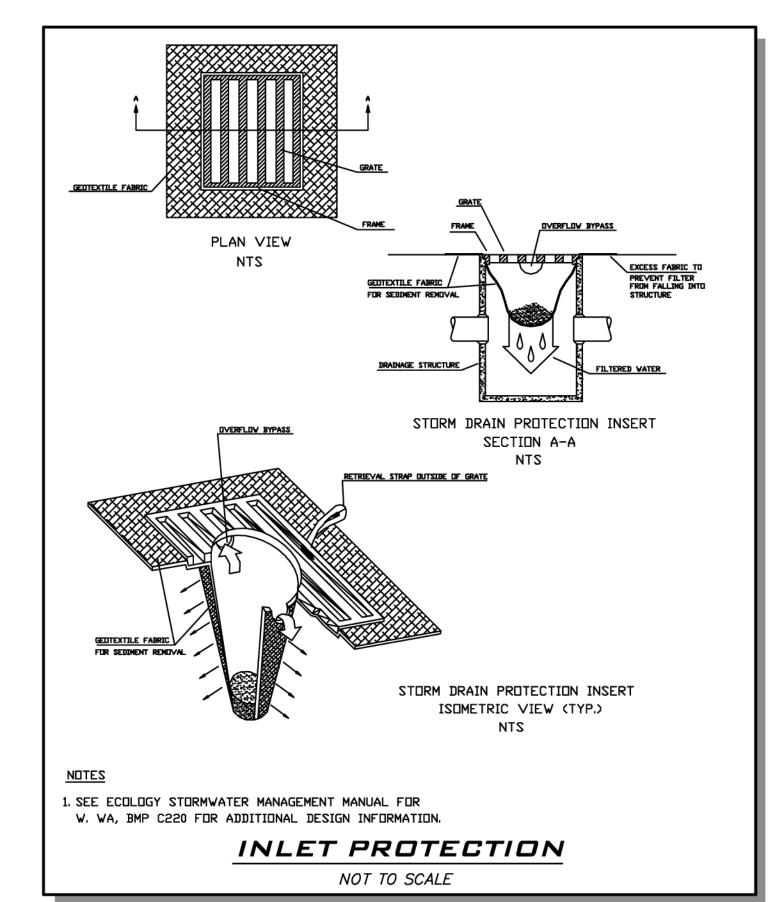

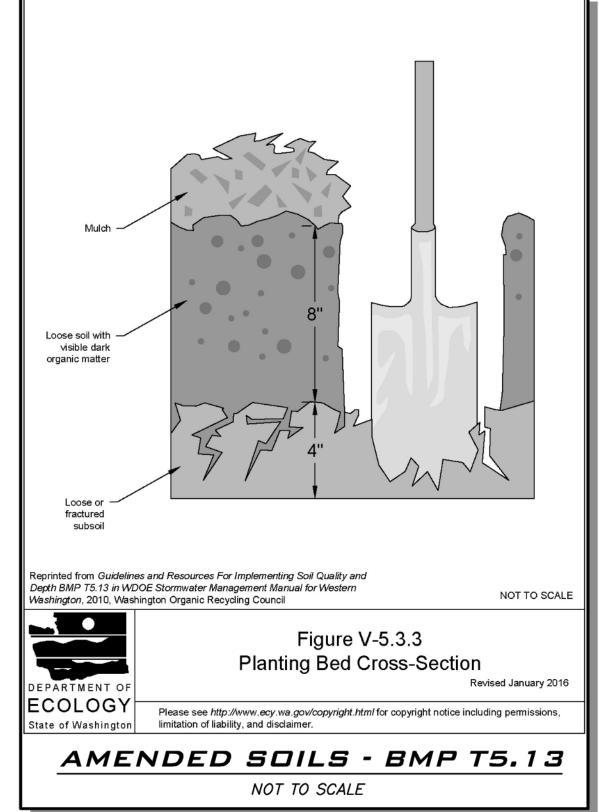

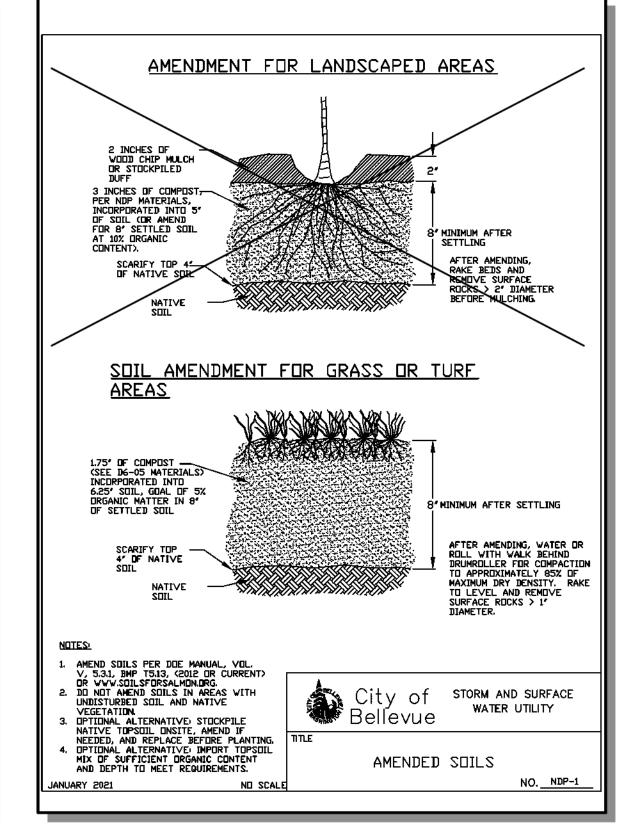

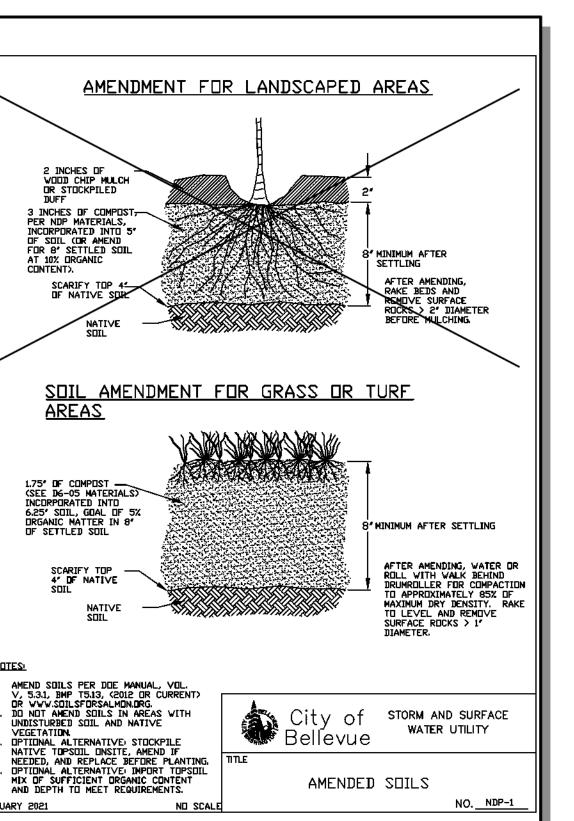

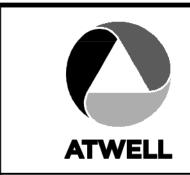

25 CENTRAL WAY, SUITE 400, KIRKLAND, WA 98033 P: 425.216.4051 F: 425.216.4052


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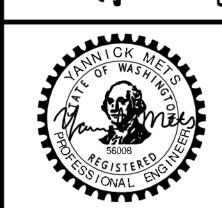
PROJECT MANAGER: YANNICK METS, PE

AS NOTED

PROJECT ENGINEER: ALI RAMEZANI, PE DESIGNER:

CHRISTOPHER WISCOMB ISSUE DATE:




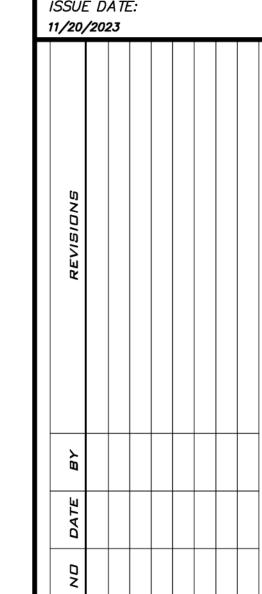

11/20/23 JOB NUMBER: 22-042


SHEET NAME: TP-02

SHT

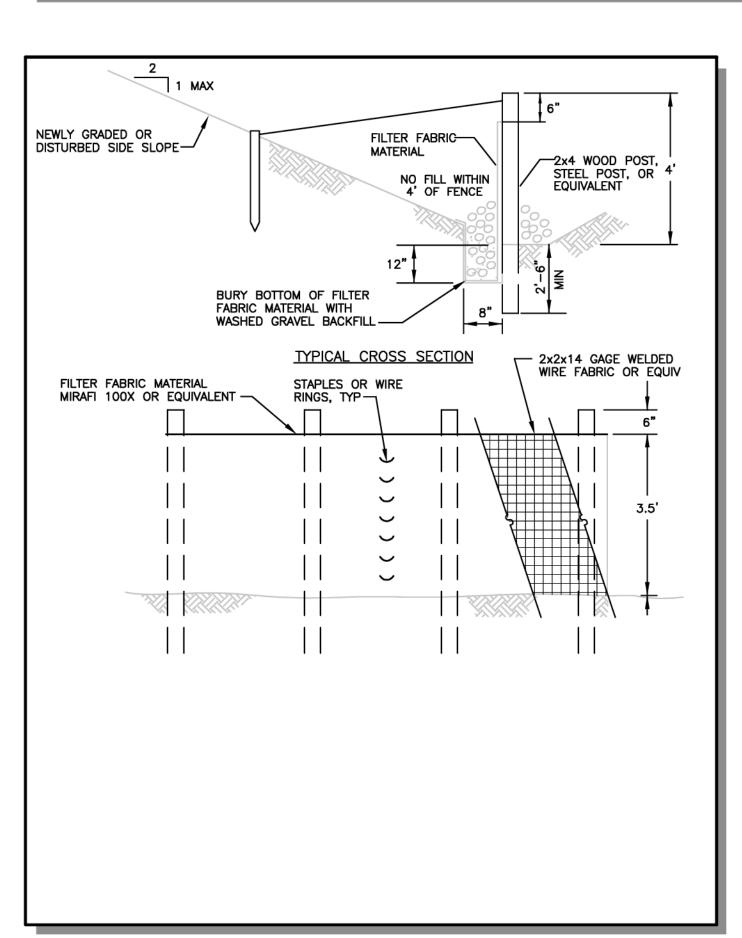

EXISTING UTILITY NOTE

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SCALE: AS NOTED

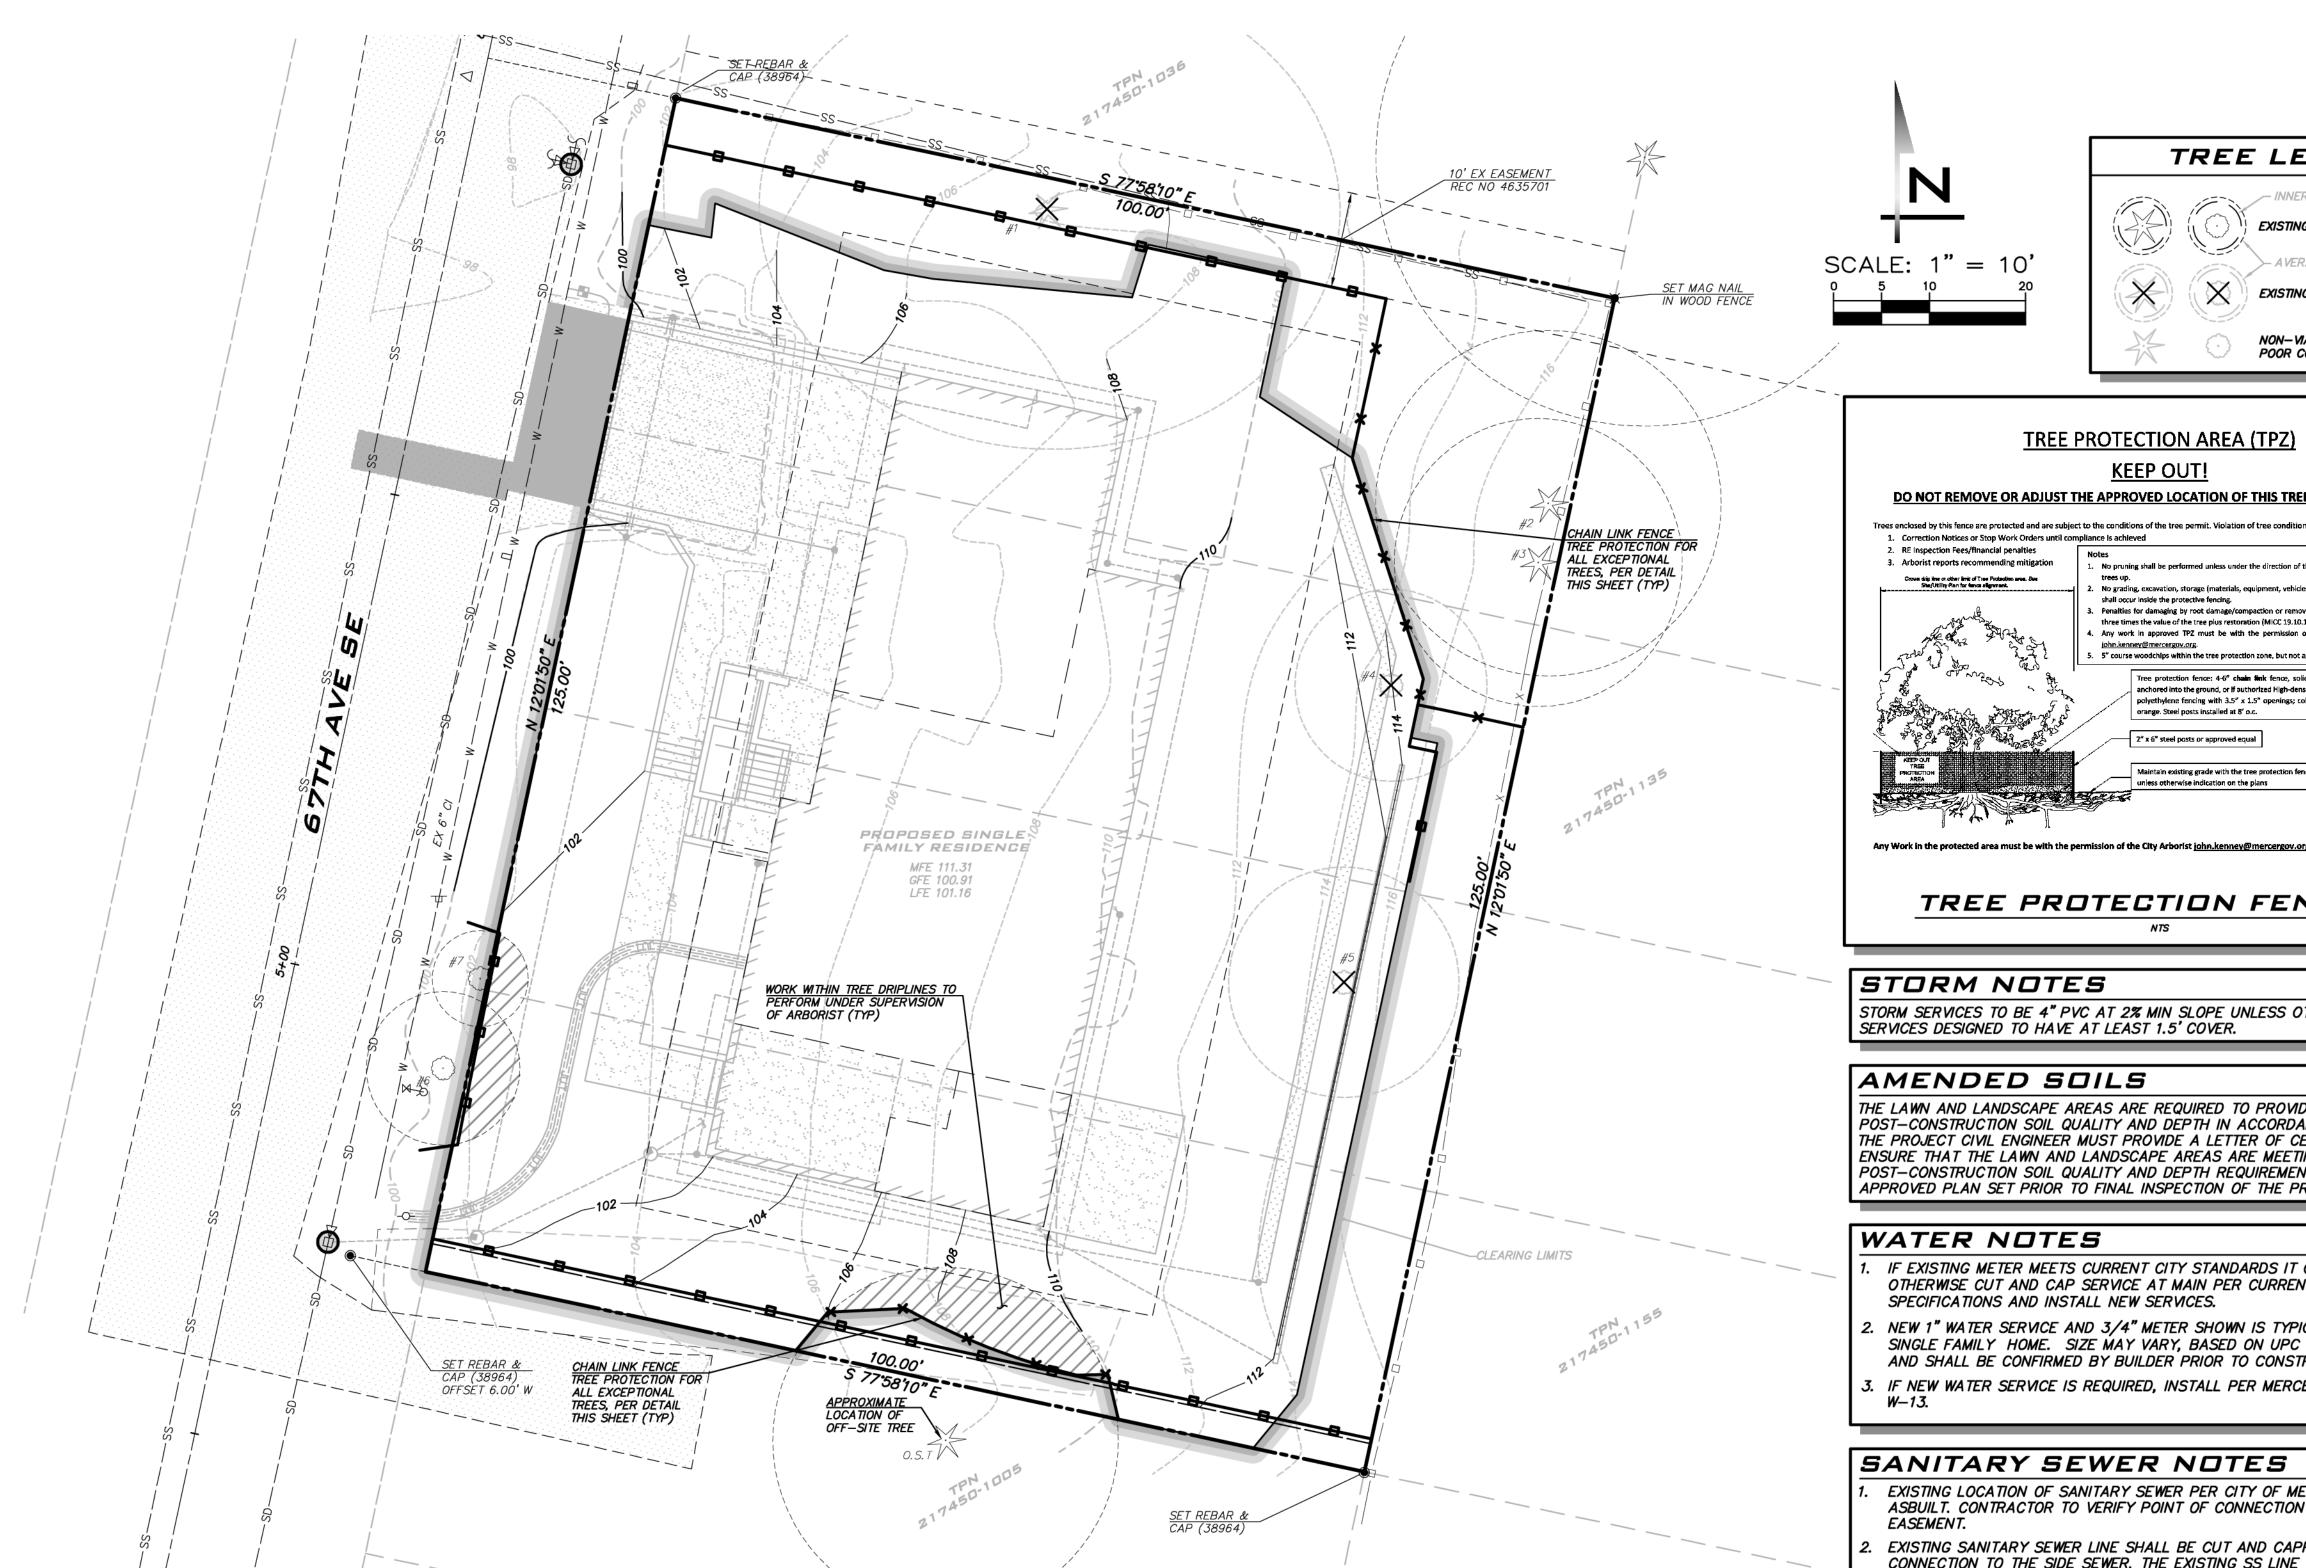11/20/2023

PROJECT MANAGER: YANNICK METS, PE PROJECT ENGINEER: ALI RAMEZANI, PE

DESIGNER: CHRISTOPHER WISCOMB ISSUE DATE:

TREE PROTECTION AREA (TPZ)

KEEP OUT! DO NOT REMOVE OR ADJUST THE APPROVED LOCATION OF THIS TREE PROTECTION AREA

TREE LEGEND

- INNER CRITICAL ROOT ZONE

EXISTING TREE TO BE REMOVED

NON-VIABLE /EXISTING TREE IN

EXISTING TREE TO REMAIN

- AVERAGE DRIP LINE

POOR CONDITION

Trees enclosed by this fence are protected and are subject to the conditions of the tree permit. Violation of tree conditions may lead to

- 1. Correction Notices or Stop Work Orders until compliance is achieved 2. RE inspection Fees/financial penalties 3. Arborist reports recommending mitigation No pruning shall be performed unless under the direction of the Project Arborist. Including limbin . No grading, excavation, storage (materials, equipment, vehicles, etc.), or other unpermitted activ Penalties for damaging by root damage/compaction or removing a saved tree may be a fine up three times the value of the tree plus restoration (MICC 19.10.160). . Any work in approved TPZ must be with the permission of the City Arboris john.kenney@mercergov.org. Tree protection fence: 4-6" chain link fence, solidly anchored into the ground, or if authorized High-density polyethylene fencing with 3.5" x 1.5" openings; color 2" x 6" steel posts or approved equal

TREE PROTECTION FENCING

STORM NOTES

STORM SERVICES TO BE 4" PVC AT 2% MIN SLOPE UNLESS OTHERWISE NOTED. SERVICES DESIGNED TO HAVE AT LEAST 1.5' COVER.

AMENDED SOILS

THE LAWN AND LANDSCAPE AREAS ARE REQUIRED TO PROVIDE POST-CONSTRUCTION SOIL QUALITY AND DEPTH IN ACCORDANCE WITH BMP T5.13 THE PROJECT CIVIL ENGINEER MUST PROVIDE A LETTER OF CERTIFICATION TO ENSURE THAT THE LAWN AND LANDSCAPE AREAS ARE MEETING THE POST-CONSTRUCTION SOIL QUALITY AND DEPTH REQUIREMENTS SPECIFIED ON THE APPROVED PLAN SET PRIOR TO FINAL INSPECTION OF THE PROJECT.

WATER NOTES


- IF EXISTING METER MEETS CURRENT CITY STANDARDS IT CAN BE RE-USED OTHERWISE CUT AND CAP SERVICE AT MAIN PER CURRENT PUBLIC WORKS SPECIFICATIONS AND INSTALL NEW SERVICES.
- 2. NEW 1" WATER SERVICE AND 3/4" METER SHOWN IS TYPICAL SIZE FOR A NEW SINGLE FAMILY HOME. SIZE MAY VARY, BASED ON UPC SIZING CRITERIA, AND SHALL BE CONFIRMED BY BUILDER PRIOR TO CONSTRUCTION.
- 3. IF NEW WATER SERVICE IS REQUIRED, INSTALL PER MERCER ISLAND SDT DTL

SANITARY SEWER NOTES

- EXISTING LOCATION OF SANITARY SEWER PER CITY OF MERCER ISLAND ASBUILT. CONTRACTOR TO VERIFY POINT OF CONNECTION WITHIN THE EASEMENT.
- EXISTING SANITARY SEWER LINE SHALL BE CUT AND CAPPED AT POINT OF CONNECTION TO THE SIDE SEWER. THE EXISTING SS LINE WITHIN THE EASE, EMT SHALL BE CLEANED, LOCATED AND INSPECTED BY CAMERA TO VERIFY SUITABILITY FOR RE-USE AND NEED FOR RE-LINING.
- PROPOSED SEWER SERVICE LINE TO BE INSTALLED PER CITY OF MERCER ISLAND STANDARD DETAIL S-18.
- . SANITARY SEWER CLEANOUT TO BE INSTALLED PER CITY OF MERCER ISLAND STANDARD DETAIL S-19.
- 5. REFER TO CITY OF MERCER ISLAND STANDARD DETAIL S-22 FOR DISCONNECTION AND RECONNECTION NOTES AND SPECIFICATIONS

EXISTING UTILITY NOTE


EXISTING UTILITIES ARE SHOWN IN THE APPROXIMATE LOCATION. THERE IS NO GUARANTEE THAT ALL UTILITY LINES ARE SHOWN, OR THAT THE LOCATION, SIZE AND MATERIAL IS ACCURATE. THE CONTRACTOR SHALL UNCOVER ALL INDICATED PIPING WHERE CROSSING, INTERFERENCES, OR CONNECTIONS OCCUR PRIOR TO TRENCHING OR EXCAVATION FOR ANY PIPE OR STRUCTURES, TO DETERMINE ACTUAL LOCATIONS, SIZE AND MATERIAL. THE CONTRACTOR SHALL MAKE THE APPROPRIATE PROVISION FOR PROTECTION OF SAID FACILITIES. THE CONTRACTOR SHALL NOTIFY ONE CALL AT 8-1-1 (WASHINGTON811.COM) AND ARRANGE FOR FIELD LOCATION OF EXISTING FACILITIES BEFORE CONSTRUCTION.

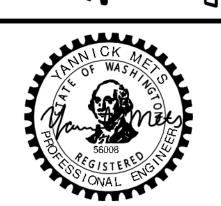

11/20/23 JOB NUMBER:

22-042 SHEET NAME: TR-01

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KIRKLAND, WA 98033 P: 425.216.4051 F: 425.216.4052 WWW.ATWELL-GROUP.COM

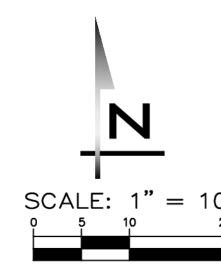SCALE: AS NOTED

PROJECT MANAGER. YANNICK METS, PE PROJECT ENGINEER:

ALI RAMEZANI, PE DESIGNER: CHRISTOPHER WISCOMB

ISSUE DATE: 11/20/2023

STORM NOTES

- STORM SERVICES TO BE 4" PVC AT 2% MIN SLOPE UNLESS OTHERWISE NOTED. SERVICES DESIGNED TO HAVE AT LEAST 1.5' COVER.
- 2. TYPE II CATCH BASINS TO BE INSTALLED PER COB STD DTL D-4. 3. STORM DRAIN CLEANOUTS TO BE INSTALLED PER COB STD DTL D-52.

AMENDED SOILS

THE LAWN AND LANDSCAPE AREAS ARE REQUIRED TO PROVIDE POST-CONSTRUCTION SOIL QUALITY AND DEPTH IN ACCORDANCE WITH BMP T5.13. THE PROJECT CIVIL ENGINEER MUST PROVIDE A LETTER OF CERTIFICATION TO ENSURE THAT THE LAWN AND LANDSCAPE AREAS ARE MEETING THE POST-CONSTRUCTION SOIL QUALITY AND DEPTH REQUIREMENTS SPECIFIED ON THE APPROVED PLAN SET PRIOR TO FINAL INSPECTION OF THE PROJECT.

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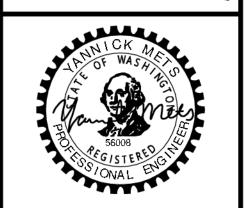
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- EXISTING SANITARY SEWER LINE SHALL BE CUT AND CAPPED AT THE EASEMENT LINE.
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- SANITARY SEWER CLEANOUT TO BE INSTALLED PER CITY OF MERCER ISLAND STANDARD DETAIL S-19.
- REFER TO CITY OF MERCER ISLAND STANDARD DETAIL S-22 FOR DISCONNECTION AND RECONNECTION NOTES AND SPECIFICATIONS
- 5. MAINTAIN MINIMUM 18" BETWEEN NEW SIDE SEWER AND OTHER UTILITIES.

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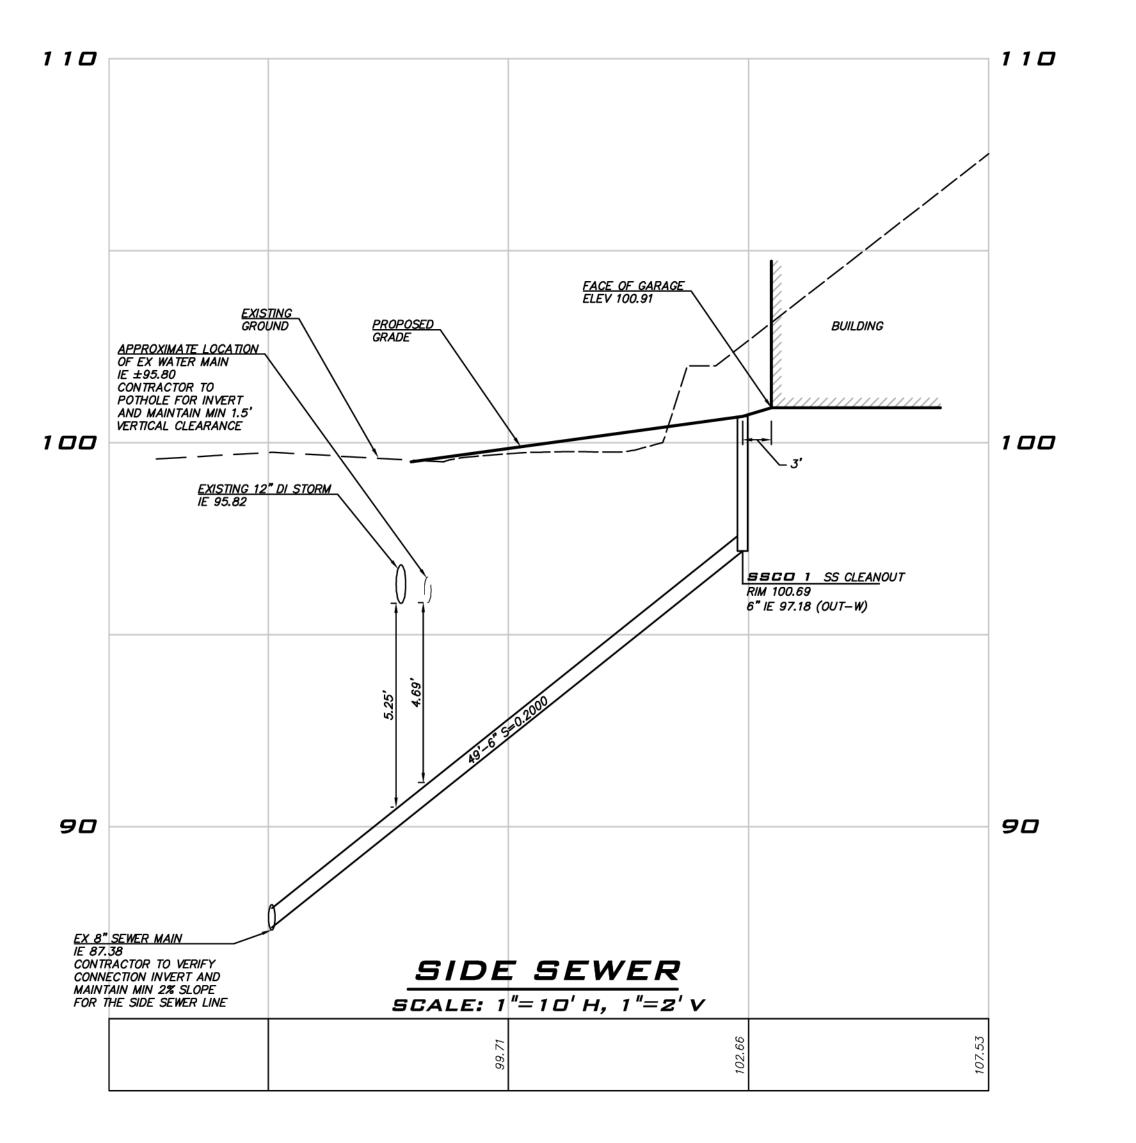
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11/20/23 JOB NUMBER: 22-042

SHEET NAME: SP-01

<u>5</u> of <u>9</u> SHT





25 CENTRAL WAY, SUITE 400, KIRKLAND, WA 98033 P: 425.216.4051 F: 425.216.4052 WWW.ATWELL-GROUP.COM

SCALE: AS NOTED

PROJECT MANAGER:

YANNICK METS, PE PROJECT ENGINEER:

ALI RAMEZANI, PE

DESIGNER: CHRISTOPHER WISCOMB

ISSUE DATE: 11/20/2023

E SEWER PROFILE

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SANITARY SEWER NOTES

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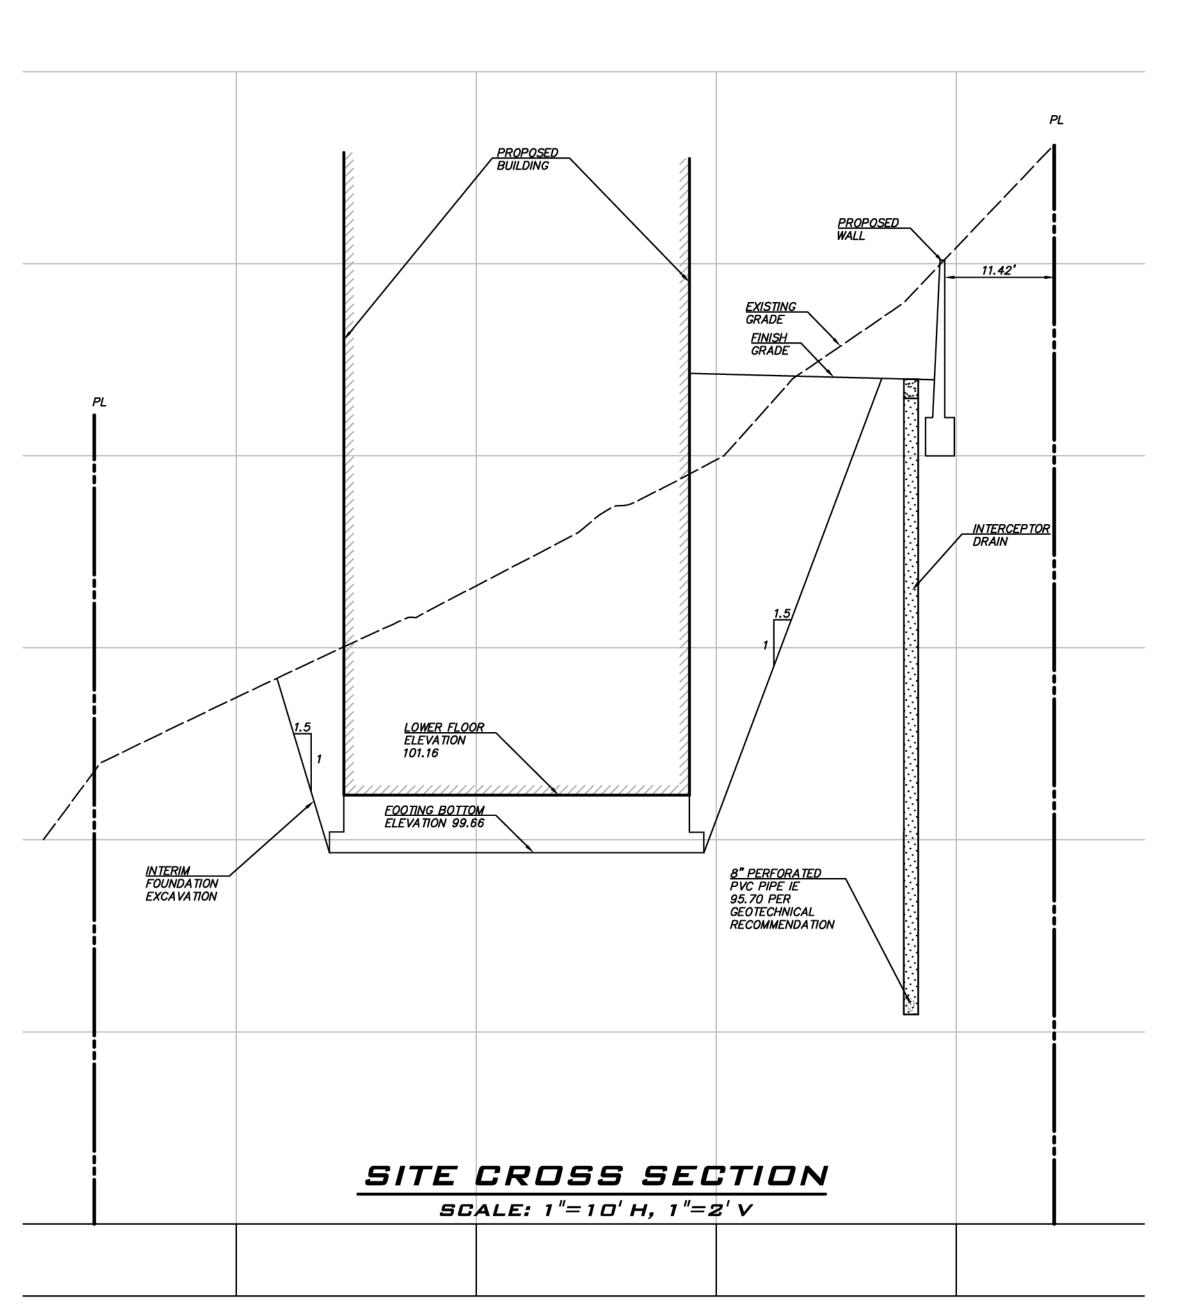





11/20/23 Job Number

22-042 SHEET NAME: SS-01

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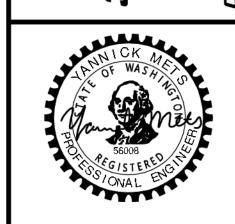
25 CENTRAL WAY, SUITE 400, KIRKLAND, WA 98033 P: 425.216.4051 F: 425.216.4052 WWW.ATWELL-GROUP.COM

SCALE: AS NOTED

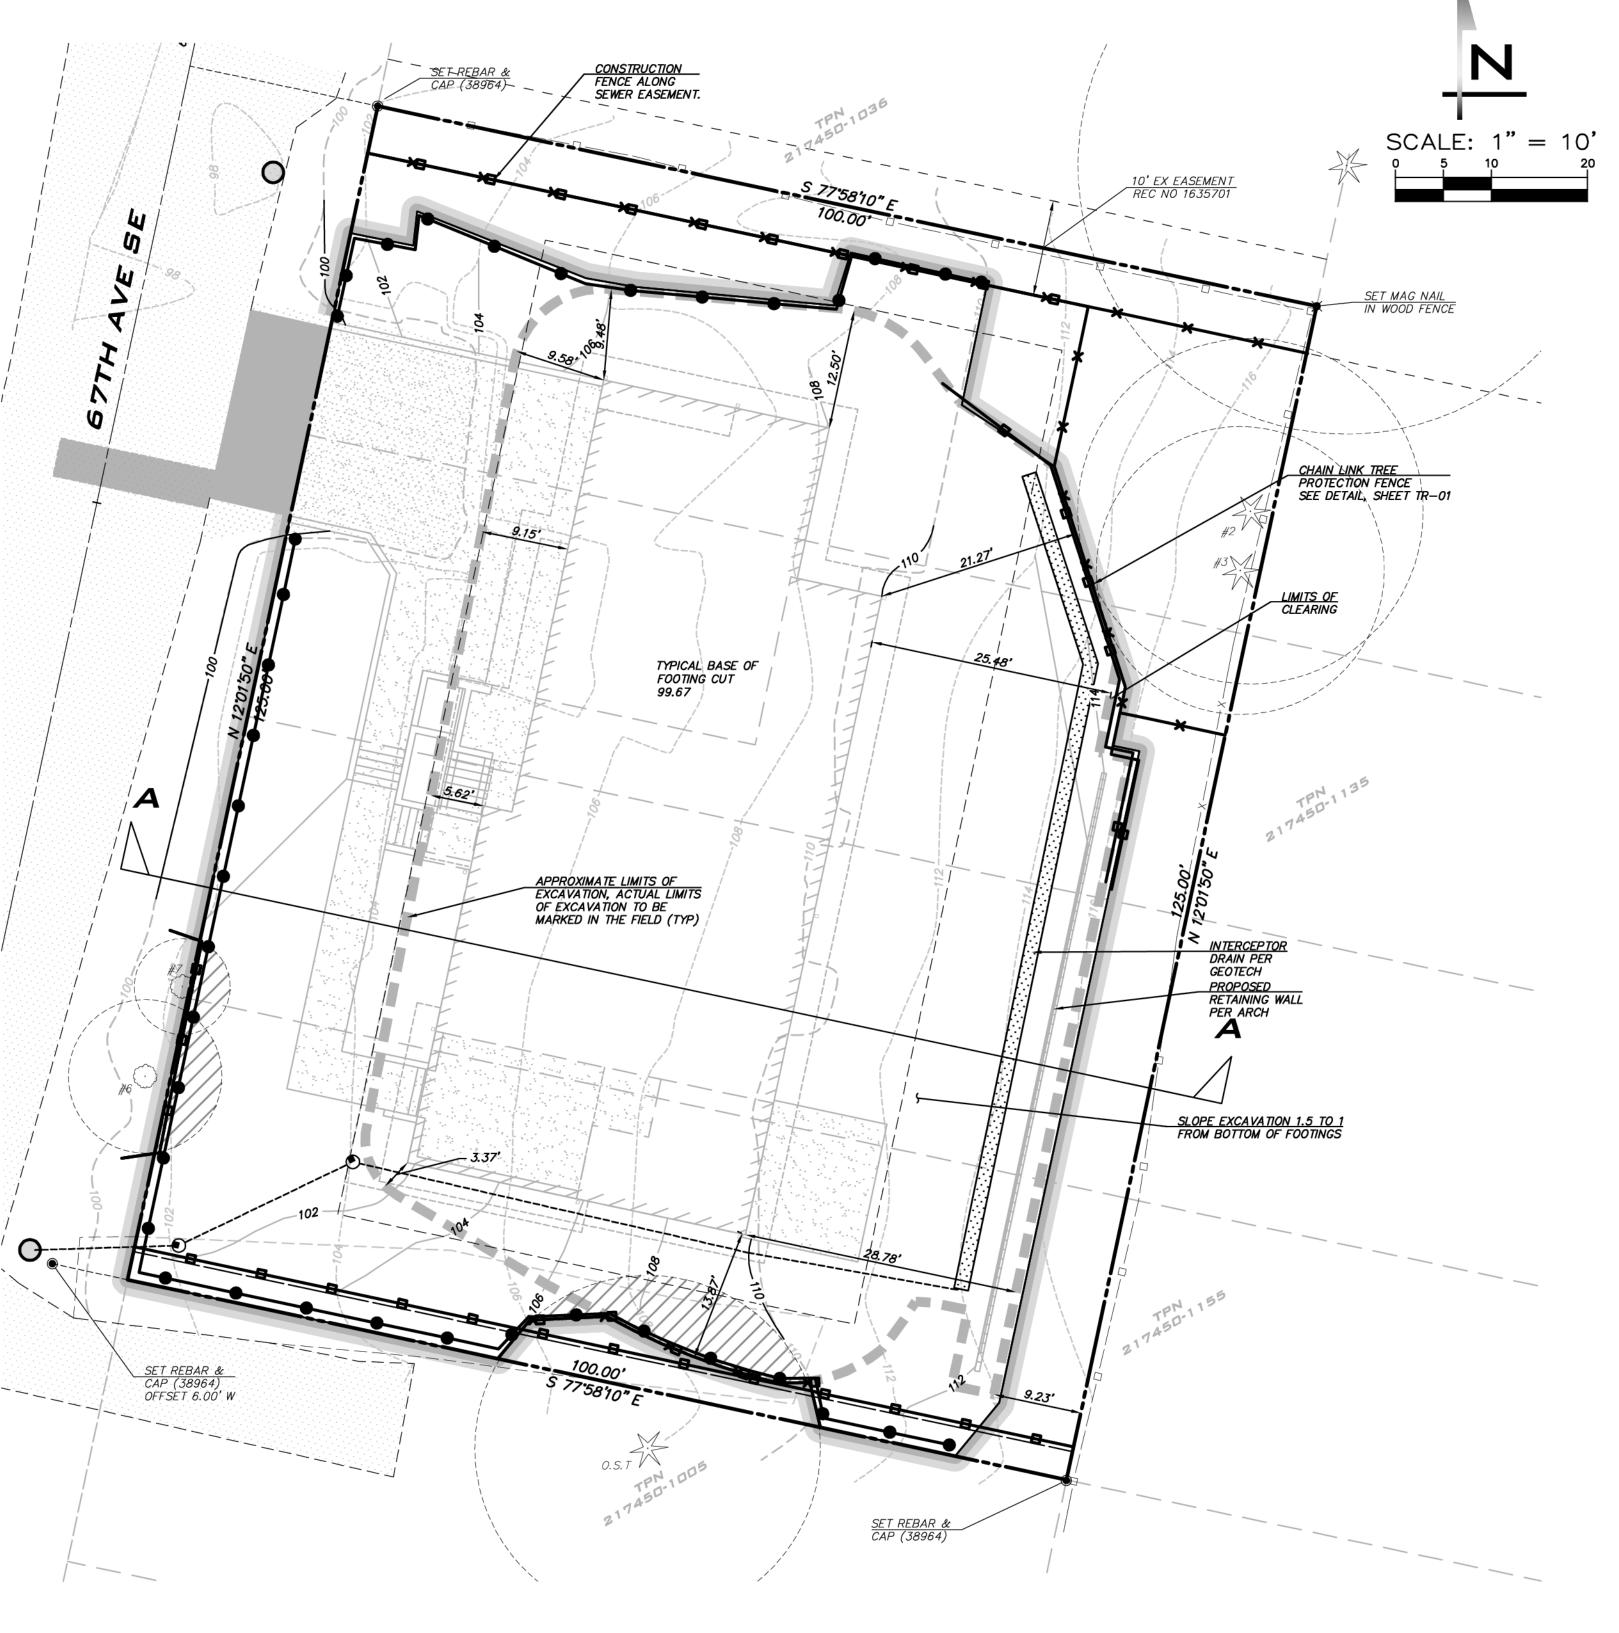PROJECT MANAGER: YANNICK METS, PE PROJECT ENGINEER:


ALI RAMEZANI, PE DESIGNER: CHRISTOPHER WISCOMB

ISSUE DATE: 11/20/2023



11/20/23 22-042

SHEET NAME: TG-0 1

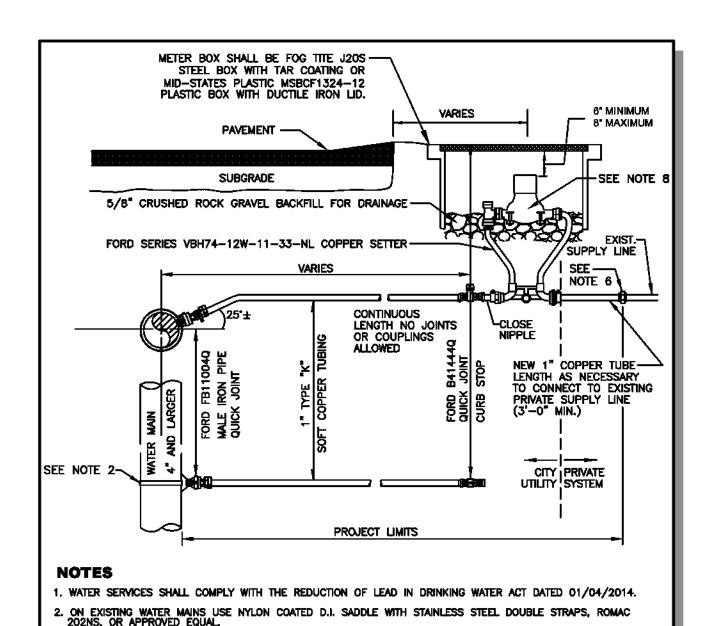

4. Plastic meter boxes shall not be installed within roadway, sidewalk, or driveways

MAIN AND STRAIGHT TO WATER METER,
S OTHERWISE APPROVED BY CITY ENGINEER.
DE WINDING SLACK IN THE SERVICE LINE
EN THE MAIN AND WATER METER.

9. ALL FITTINGS TO BE BRASS COMPRESSION TYPE, FORD QUICK JOINT OR EQUAL.

B. WATER METER SUPPLIED BY CITY.

B. WHEN CONNECTING TO EXISTING PRIVATE SUPPLY LINE CONTAINING FERROUS METAL, PROVIDE INSULATING COUPLING (DB SERIES WITH C21 SERIES ADAPTERS) AND PROVIDE REDUCER AS NECESSARY TO MATCH EXISTING PRIVATE SUPPLY LINE DIAMETER.

02-05-2021

CITY OF MERCER ISLAND STANDARD DETAILS


1" WATER METER INSTALLATION


NO SCALE

6-5-2009


S-18


APPROVED

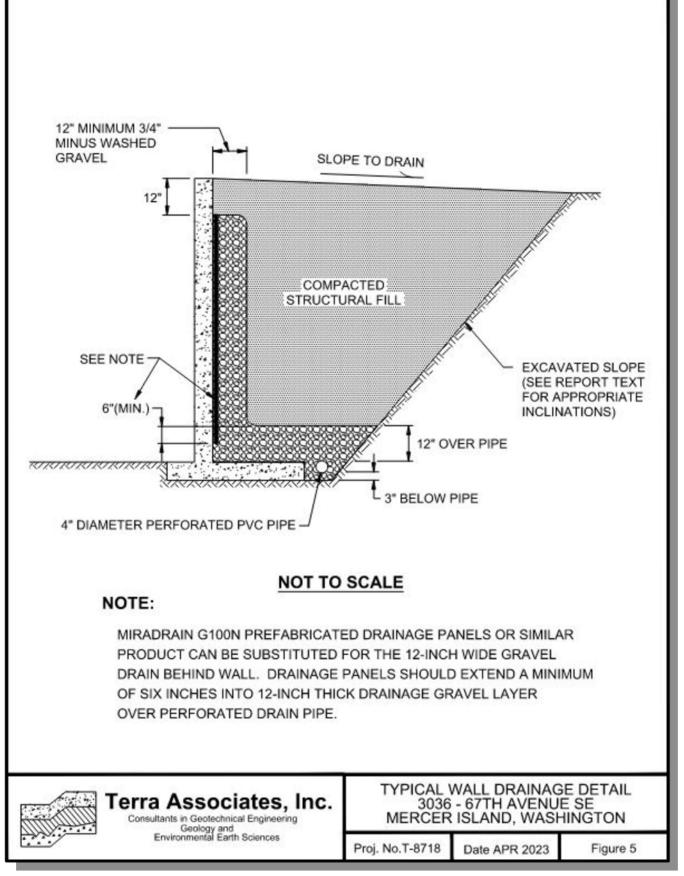


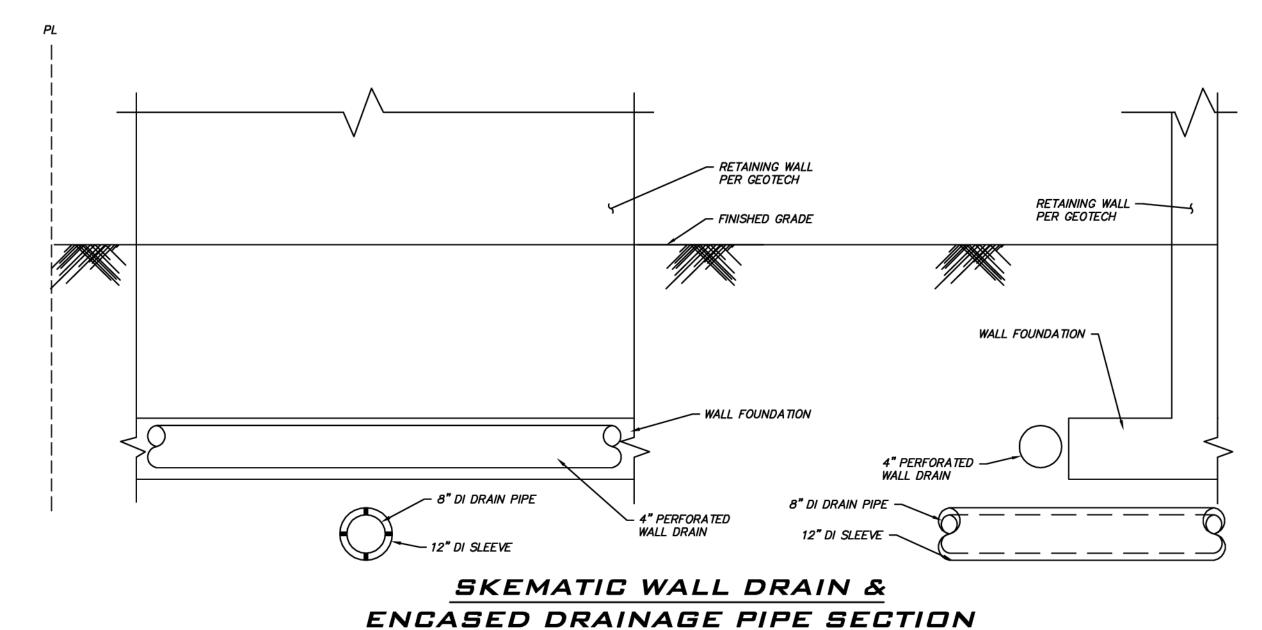


NOT TO SCALE

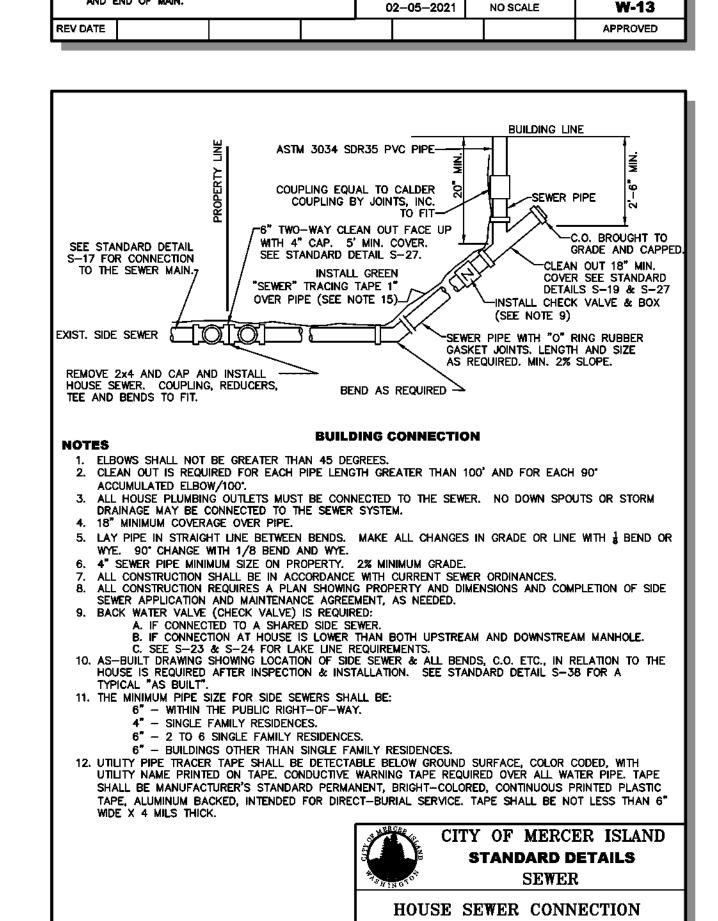


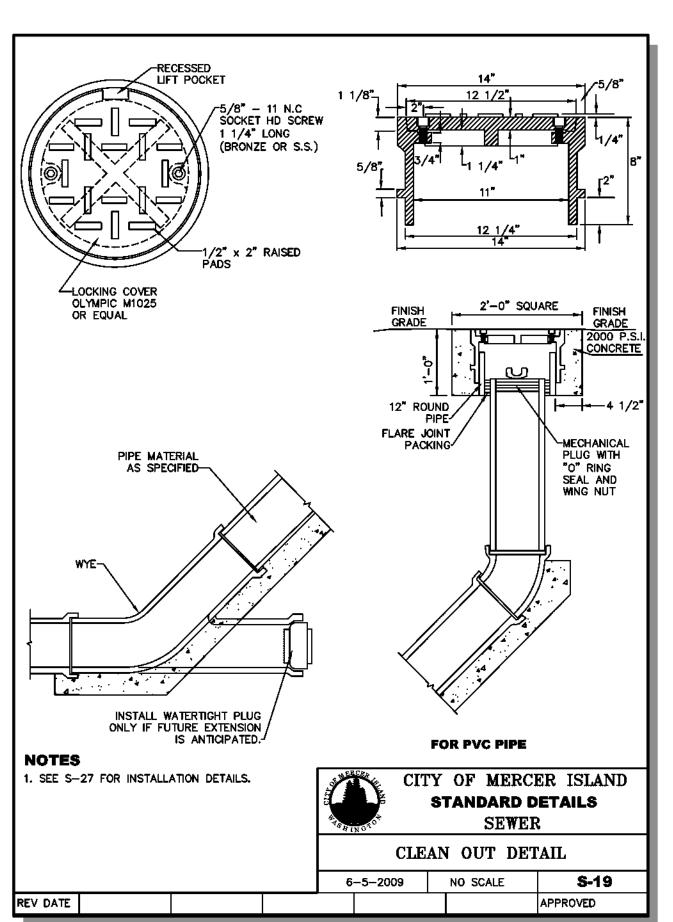

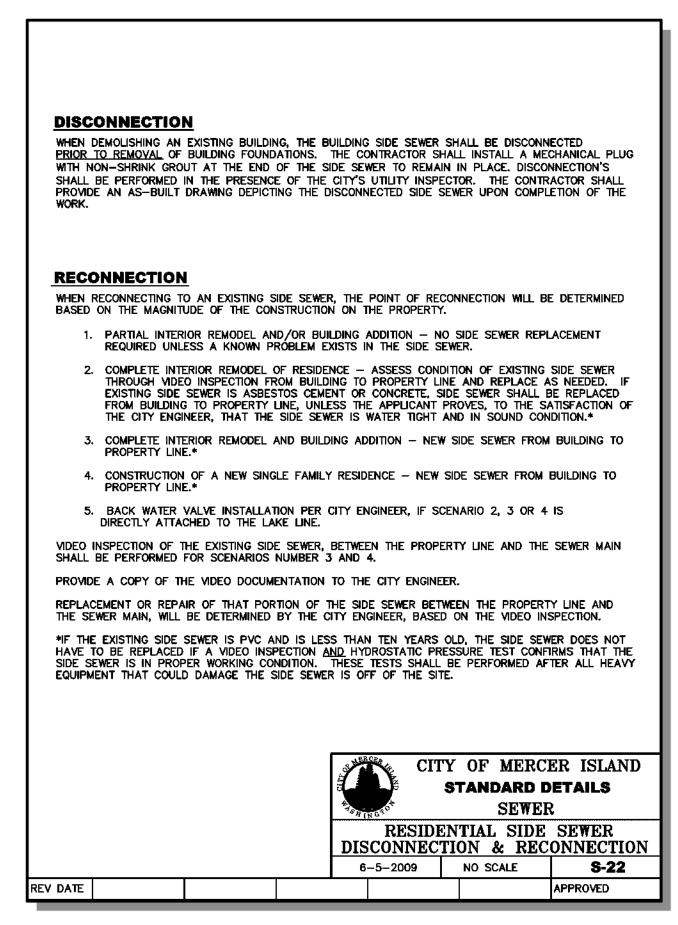

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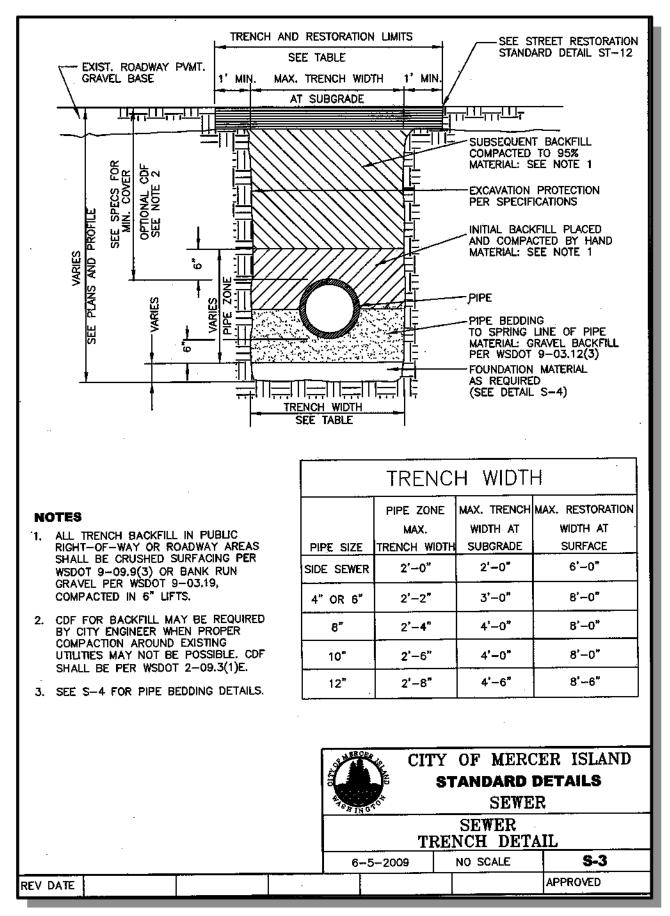


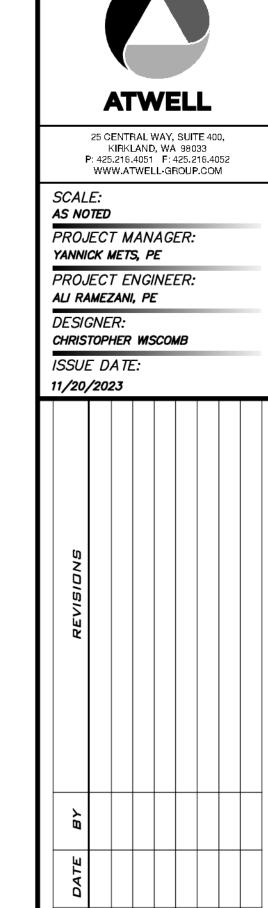
11/20/23 JOB NUMBER:

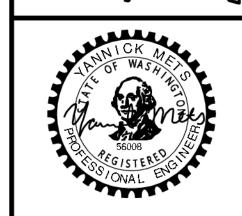
22-042 SHEET NAME: DT-0 1


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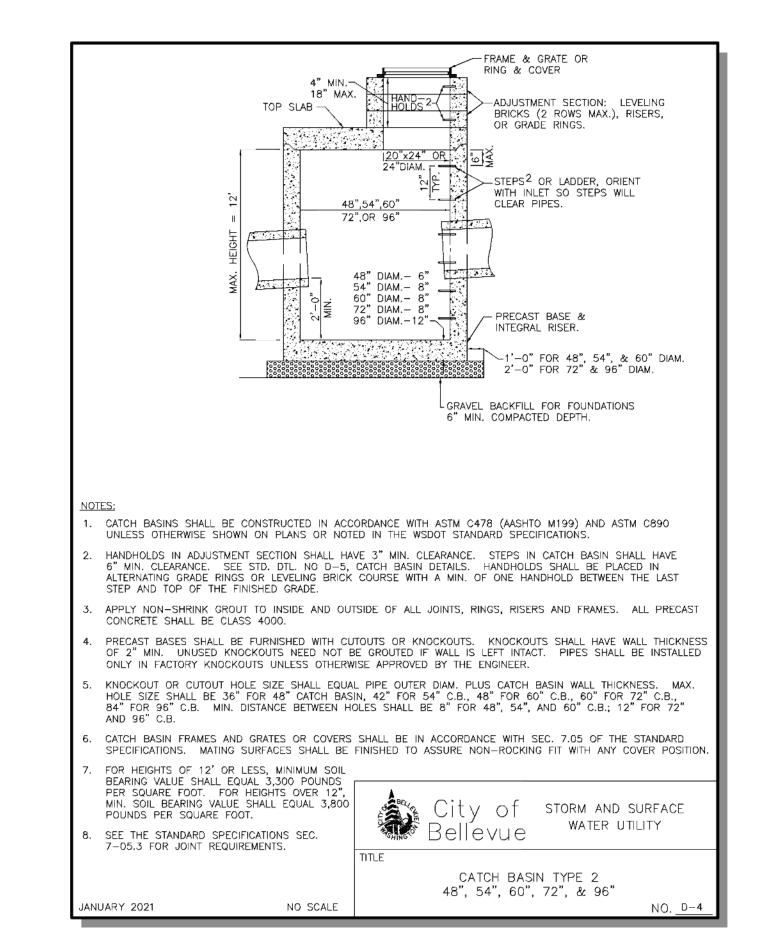
REV DATE





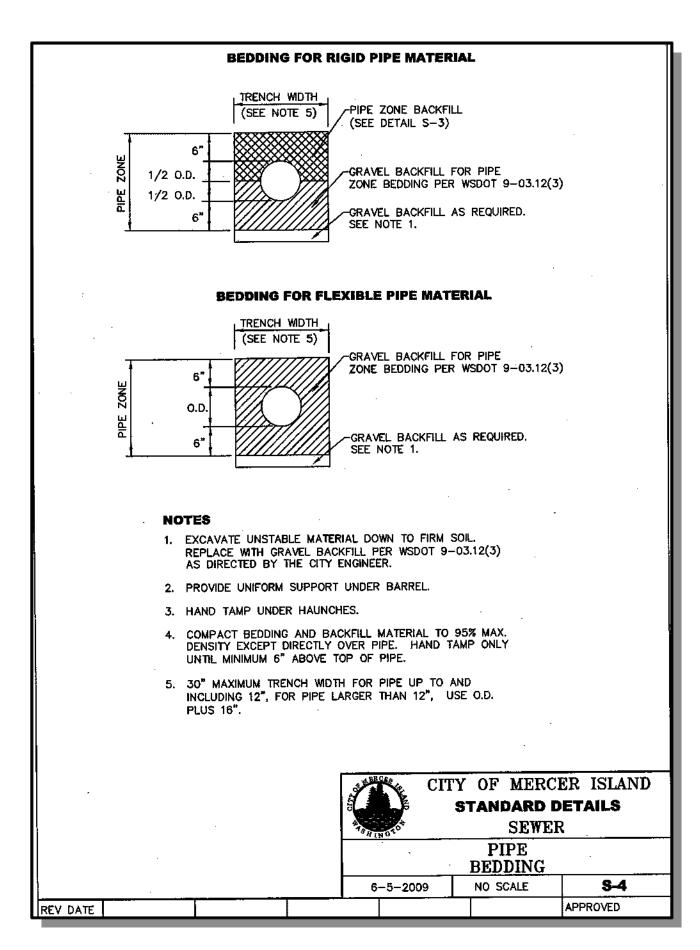

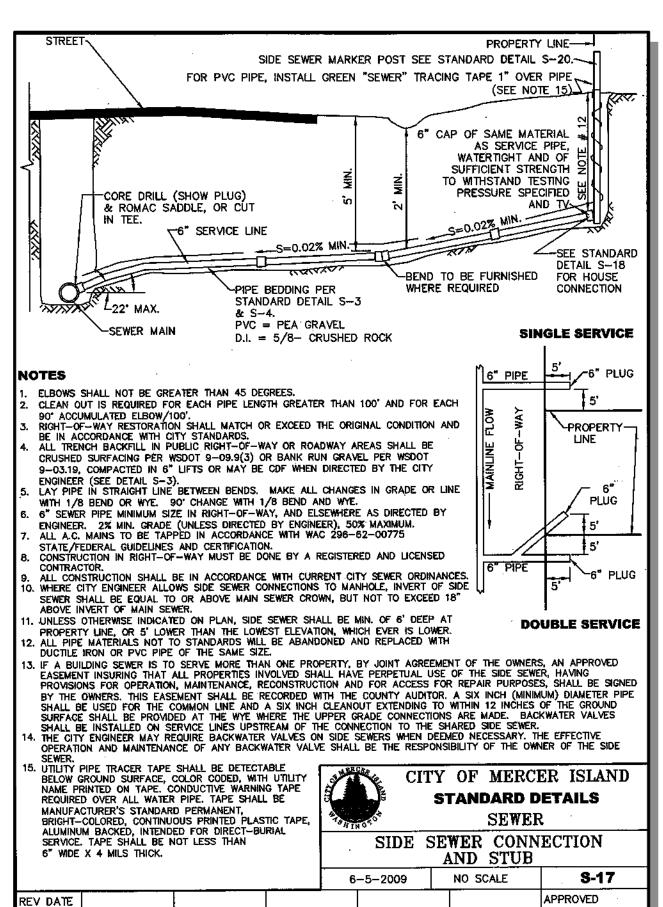

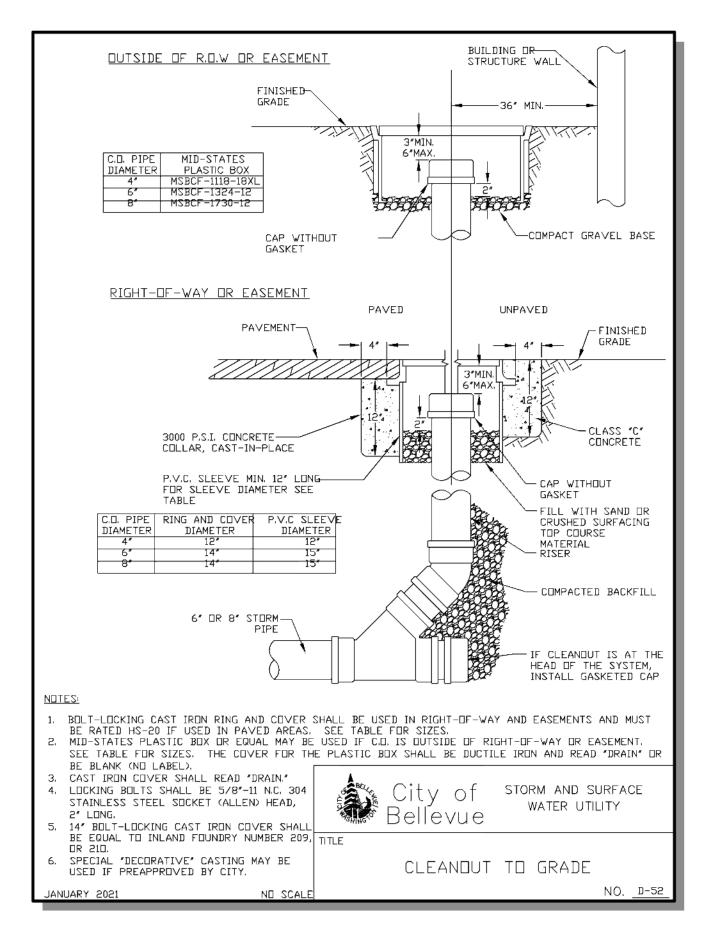



25 CENTRAL WAY, SUITE 400, KIRKLAND, WA 98033 P: 425.216.4051 F: 425.216.4052 WWW.ATWELL-GROUP.COM

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CHRISTOPHER WISCOMB
ISSUE DATE:

ISSUE DATE:
11/20/2023

REVISIONS

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SITE PLA PARCEL 21745

TRUNK OF WASHINGS

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